## SEVIERVILLE BOARD OF ZONING APPEALS

## 2/1/2024

5:00 P.M. – Civic Center



# Board of Zoning Appeals AGENDA 2/1/2024

- A. Call to Order
- B. Approval of Minutes -12/7/2023
- C. Public Forum
- D. Old Business
- E. New Business
  - 1. Case 24-01 Flag Systems requests a height variance of 86 feet on a non-building structure for Camping World 210 East Dumplin Valley Road.
- F. Staff Report
- G. Adjournment



# BOARD OF ZONING APPEALS MINUTES DECEMBER 7, 2023

The regularly scheduled meeting of the Sevierville Board of Zoning Appeals was held at the Civic Center, 130 Gary Wade Boulevard, Sevierville, Tennessee on Thursday, December 7, 2023 at 5:58 PM.

There were present and participating:

#### **MEMBERS PRESENT**

Vincent Snider, Chairman Austin Williams, Vice Chairman Douglas Messer, Secretary Robbie Fox Wayne Helton Daryl Roberts Butch Stott

#### **STAFF PRESENT**

Dustin Smith, Deputy City Administrator Corey Divel, Development Director Kristina Rodreick, Senior Planner Charles Valentine, Building Official JC Green, Fire Marshal Jim Ellison, City Surveyor Brooke Fradd, Recording Secretary

#### **MEMBERS ABSENT**

None

Chairman Snider declared a quorum present and announced the meeting would proceed.

#### APPROVAL OF MINUTES

Mr. Messer made a motion to approve the minutes of the November 2, 2023, meeting. The motion received a second from Mr. Williams and passed with a unanimous vote.

#### **OLD BUSINESS**

None

#### **NEW BUSINESS**

<u>Case 23-20 – Custom Crafted Construction, LLC requests a structure height variance</u> – 1654 Veterans Boulevard, Unit #43.

<u>Case 23-21 – Custom Crafted Construction, llc requests a structure height variance</u> – 1654 Veterans Boulevard, Unit #43.

Mr. Divel explained that, due to the identical nature of the requests, they would be presented together.

He stated that both structures are almost completed units with some topography issues. Both buildings have frontage on Veterans Boulevard but are accessed from internal subdivision roads. Due to the topography of the lot, the rear of the structures exceed the allowable height as defined by the City's Zoning Ordinance.

The commission and staff discussed how these two structures are the tallest in the development. Additionally, they stated that the other buildings met city standards, and, with modifications, these could also be brought into compliance.

#### **Action Taken**

Mr. Helton made a motion to deny the variance request. The motion received a second from Mr. Fox and passed with a unanimous vote.

CASE 23-22 – THE ART COMPANY REQUESTS A VARIANCE TO THE MINIMUM DISTANCE REQUIREMENT FROM ANY SCHOOL, CHURCH, PUBLIC ASSEMBLY, AND/OR RESIDENTIAL ZONING DISTRICT FOR A TATTOO BUSINESS – 1811 PARKWAY.

Mr. Divel explained that this request is due to the 1,000 feet separation requirement for tattoo businesses. The proposed location is zoned Arterial Commercial (AC) and abuts a Low Density Residential (LDR) district directly behind it. The variance would allow the business to encroach into the buffer by 980 feet.

#### **Action Taken**

Mr. Stott made a motion to deny the variance request. The motion received a second from Mr. Fox and passed with a unanimous vote.

#### **ADJOURNMENT**

There being no further business, the meeting	g adjourned at 6:19 PM.
Vincent Snider, Chairman	Douglas Messer, Secretary
Brooke Fradd, Recording Secretary	



# City of Sevierville Board of Zoning Appeals

Case Number: 24-01

Action Requested: Variance Request

Applicant: Flag Systems

Address: East Dumplin Valley Rd

**Tax Map:** 008F

Group/Block: A

Lot No./Parcel No: 001-009

Lot Size:

**Zoning District**: AC (Arterial Commercial District)

Request Consideration: A variance of 86 feet to allow a

130' flag pole

## **GENERAL NOTES**

**PRIMARY CODES AND SPECIFICATIONS:** 

1. GENERAL BUILDING CODE:

A. INTERNATIONAL BUILDING CODE, 2012

B. NAAM FP-1001-97

2. STRUCTURAL STEEL CODES:

A. SPECIFICATION FOR STRUCTURAL STEEL BUILDINGS, (AISC 360-10).

### <u>DESIGN LOADS:</u> 1. WIND LOADS:

A. LOADS BASED ON ASCE 7-10 WIND LOAD CRITERIA.

BUILDING CATEGORY I

BASIC WIND SPEED, 3 SECOND GUST ...... UL TIMATE 115 MPH (90 MPH NOMINAL)

GUST EFFECT FACTOR, G...... 1.14

B. FLAG LOAD ...... 724 LB MAX. BASED ON MAX 30'X60' POLYESTER FLAG

# FOUNDATIONS:

1. FOUNDATION DESIGN IS BASED ON TABLE 1806.2, CLASS 5

2. CAST IN PLACE FOUNDATION CALCULATED WITH SECTION 1807.3.2.1 NON-CONSTRAINED CASE

## <u>CAST-IN-PLACE CONCRETE:</u>

1. THE LATEST EDITION OF THE FOLLOWING ACI STANDARDS APPLY:

ACI 318 (CODE) ACI 304 (PLACING)

ACI 306 (WINTER CONCRETING) ACI 315 (DETAILING)

ACI 305 (HOT WEATHER CONCRETING) ACI 347 (FORMWORK) ACI 211.1 (MIX PROPORTIONING) ACI 301 (SPECIFICATIONS)

2. ALL CONCRETE SHALL BE NORMAL WEIGHT (148 PCF DRY DENSITY, MIN), WITH MIXES DESIGNED TO MEET A MINUMUM OF 2500 PSI 28-DAY COMPRESSIVE STRENGTH UNLESS OTHERWISE NOTED.

3. A CONCRETE MIX DESIGN FOR EACH UNIQUE COMBINATION OF STRENGTH, COARSE AGGREGATE GRADATION AND WATER CEMENT RATIO SPECIFIED SHALL BE PREPARED BY THE SUPPLIER OR AN INDEPENDENT TESTING LABORATORY AND BE SUBMITTED FOR REVIEW PRIOR TO CASTING ANY CONCRETE. MIXES THAT WILL BE TRANSPORTED AT THE PROJECT SITE BY PUMPING SHALL BE SPECIFICALLY DESIGNED FOR PUMPING.

# REINFORCING STEEL (WHERE APPLICABLE):

1. REINFORCING STEEL: ASTM A 615, GRADE 60. 2. MINIMUM REINFORCING STEEL CLEAR COVER (U.N.O.):

A. CONCRETE CAST DIRECTLY AGAINST EARTH ...... 3"

STRUCTURAL STEEL:

1. SEE NOTES ON PRIMARY CODES AND SPECIFICATIONS.

2. MATERIALS:

HSS SHAPES.... ... ASTM A500, GRADE B

ANCHOR RODS..... .....ASTM F1554, GRADE 55 TYPE S1 (UNO) WELDING ELECTRODES..... ...... AWS D1.1, E70 SERIES

3. WHERE SPECIFIED, NON-SHRINK, NON-METALLIC GROUT WITH A 28 DAY STRENGTH OF 5000 PSI SHALL BE USED UNDER BASE PLATES AND SHALL CONFORM TO CORPS OF ENGINEERS

CRD-C621, FACTORY PREMIX GROUT. SEE SPECIFICATIONS FOR TESTING REQUIREMENTS. 4. ENGINEER SHALL BE CONTACTED FOR APPROVAL OF ANY FIELD MODIFICATIONS OF ANCHOR BOLTS OR RODS AND COLUMN BASE PLATES (PER OSHA).

5. TEMPORARY BRACING OF STRUCTURAL STEEL ELEMENTS IS THE RESPONSIBILITY OF THE CONTRACTOR. STRUCTURAL STABILITY SHALL BE MAINTAINED AT ALL TIMES DURING THE ERECTION PROCESS.


6. PROVIDE ONE SHOP COAT OF PRIMER (TT-P-636) ON ALL STEEL EXCEPT FOR ITEMS TO BE HOT DIPPED GALVANIZED OR SPRAY FIREPROOFED. DO NOT PAINT PORTIONS EMBEDDED IN CONCRETE.


8. ALL WELD OPERATORS SHALL BE CURRENTLY AWS QUALIFIED. 9. SHOP CONNECTIONS SHALL BE WELDED OR HIGH STRENGTH BOLTED. USE 3/16" FILLET WELD


10. FIELD CONNECTIONS SHALL BE WELDED OR HIGH STRENGTH BOLTED AS DETAILED. NO FIELD WELDING OF HOT DIPPED GALVANIZED MEMBERS WILL BE ALLOWED. USE 3/16" FILLET WELD


STEEL SEGMENT LEGEND: 6 - HSS 6.625X.280 8 - HSS 8.625X0.322 10 - HSS 10.75X0.375 12 - HSS 12.75X0.375 14 - HSS 14.0X0.375 16 - HSS 16.0X0.375 18 - HSS 18.0X0.375

TABLE OF DIMENSIONS							
LARGER DIAM. SEGMENT HSS	PLATE 1	PLATE 1 HOLE DIAMETER	PLATE 2	PLATE 2 HOLE DIAMETER	DISTANCE A		
8.625X0.322	₱7.875" X 0.375"	ø5.5 <b>"</b>	\$8.625" X 0.375"	ø6.75	12"		
10.75X0.375	₱9.875" X 0.500"	<b>Ø7.5</b> "	₱10.75" X 0.500"	<b>Ø8.75</b>	15"		
12.75X0.375	Ø11.875" X 0.500"	ø9.5°	\$12.75" X 0.500"	ø10.875	20**		
14.0X0.375	Ø13.125" x 0.625"	ø11.5"	Ø14.0" x 0.625"	ø12.875	20"		
16.0X0.375	Ø15.125" x 0.75"	ø12.5°	₱16.0" x 0.75"	ø14.125	24"		
18.0X0.375	\$17.125" x 0.875"	<b>∮14.5</b> "	₱18.0" x 0.875"	ø 16.125	27"		

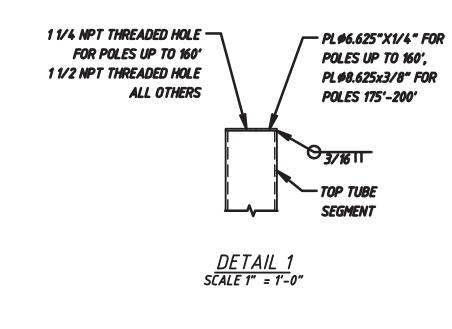


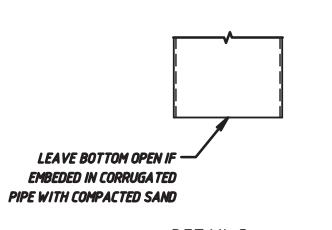

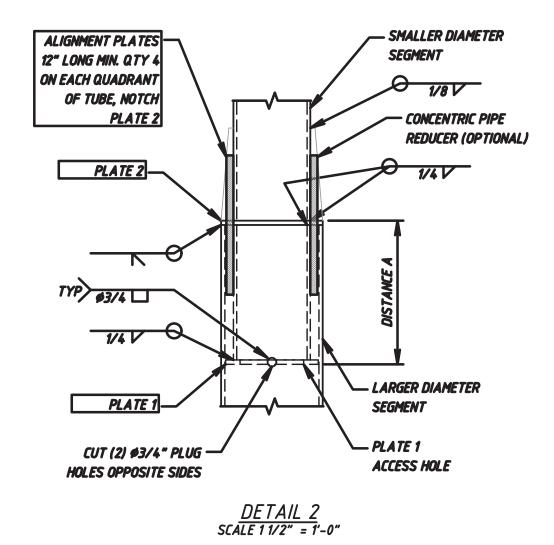

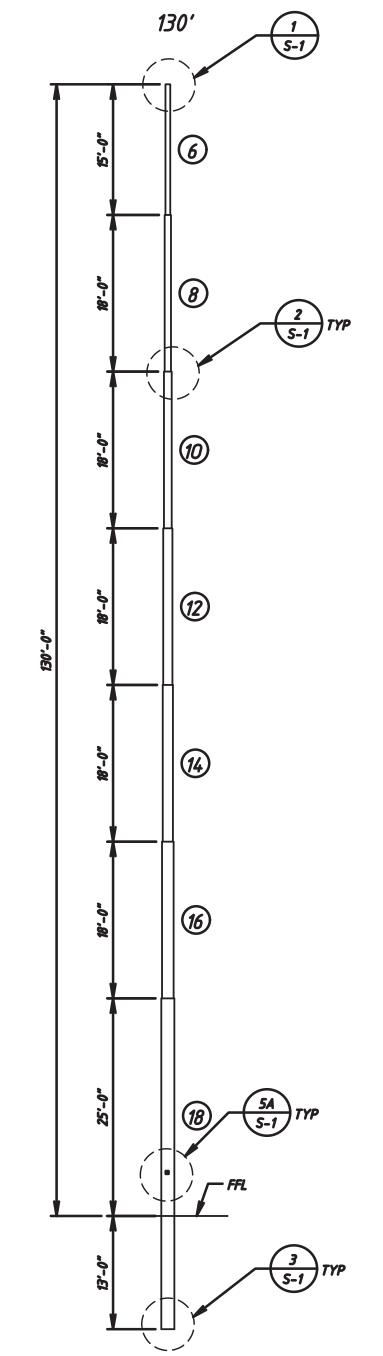




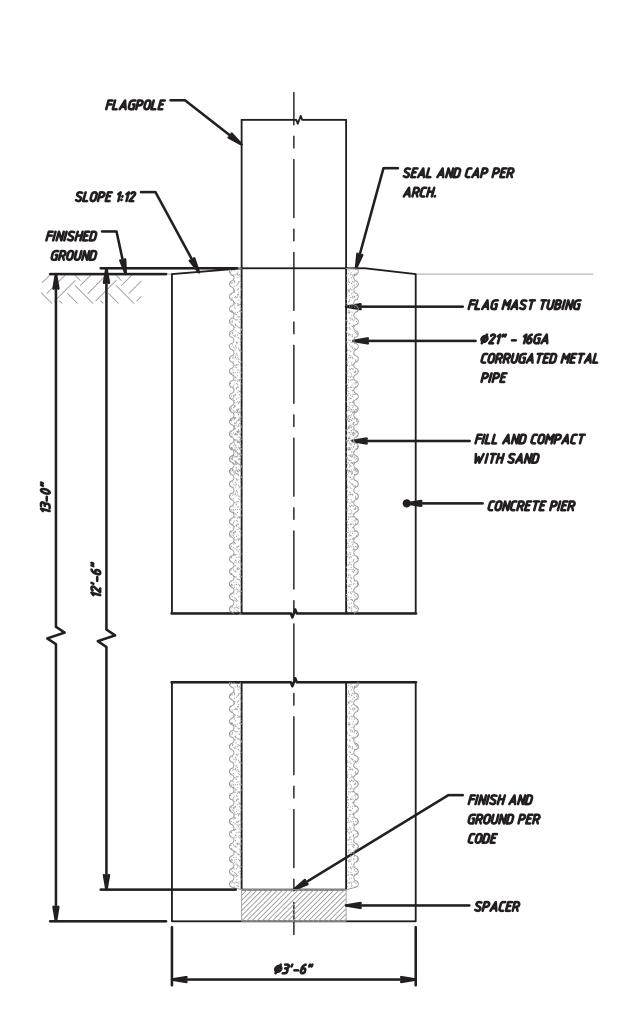

FOOTING DETAIL

<u>SCALE: 1/8" = 1'-0"</u>

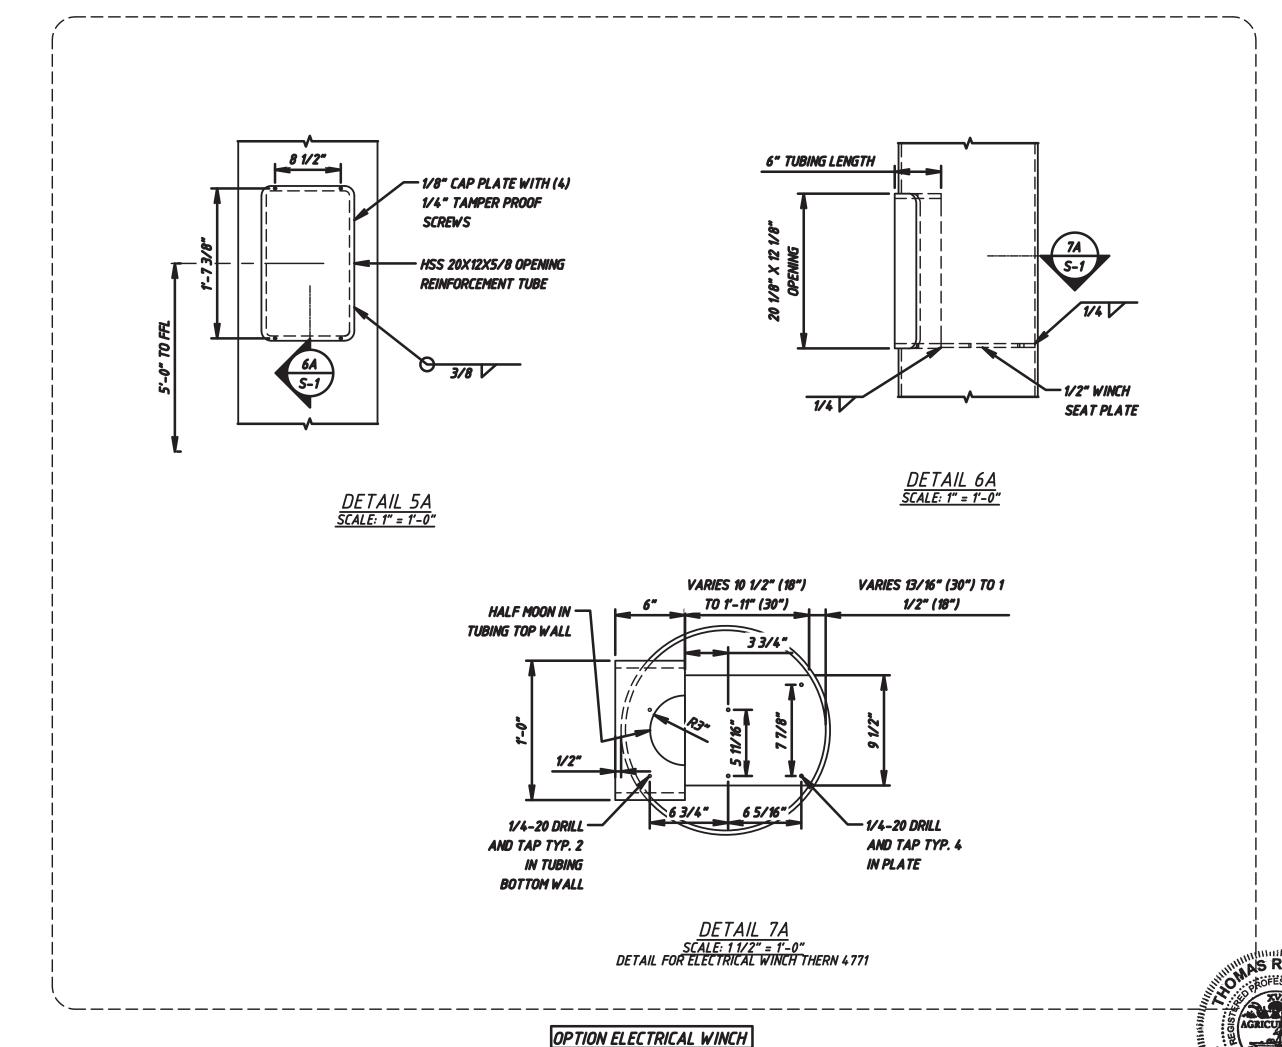

DRW CHK APP REV DATE REVISION

> **CLIENT** FLAG SYSTEMS



TBPE FIRM #: 14437

**PROJECT** 

**CAMPING** WORLD

LOCATION

EAST DUMPLIN VALLEY ROAD SEVIERVILLE, TN, 37764


**DRAWING TITLE:** 


130' FLAGPOLE FOUNDATION AND STEEL POLE DETAILS

	Drawn Date MEX 01/15/24	Check. FPRE		App. FPRE	Date 01/15/24	
Walling Wall	Project Number	SCALE		Dwg Sheet Size		
WHITE STREET	2330	AS NOTED		D		
IIIIIIIIIIIIIIIIIIIIIIIIIIIIIIIIIIIIII	Drawing No.			F	REV	
III	CAM-S-1					



CAMPING WORLI SEVIERVILLE, Th

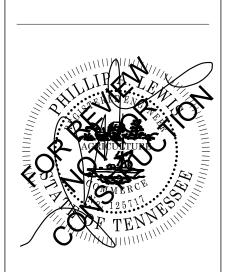

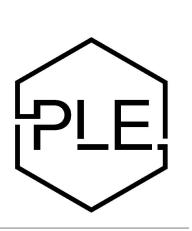

Project number:

Date: 03 November, 2022

Revisions:

OVERALL SITE PLAN

C1.1

